

DOOR SCHEDULE												
DOOR NO	TYPE	OPENING SIZE	MAT'L	LVR/U.C.	MAT'L	JAMB	HEAD	SADDLE	UL LABEL SET	HDWR	REMARKS	
201	A	2 (3'-0" X 7'-6 1/4")	H.M.		H.M.	*	*	*		1	*200 DOORS, SEE DETAILS ON DRAWING A2-10	
202	A	2 (3'-0" X 10'-2")	H.M.		H.M.	*	*	*		2	*200 DOORS, SEE DETAILS ON DRAWING A2-10	
203	A	2 (3'-0" X 10'-2")	H.M.		H.M.	*	*	*		2	*SEE DETAILS ON DRAWING A2-10	
204	A	2'-0" X 5'-6"	H.M.		H.M.	*	*	*		3	*SEE DETAILS ON DRAWING A2-10	
205	A	3'-0" X 7'-6 1/4"	H.M.		H.M.	*	*	*		4	*SEE DETAILS ON DRAWING A2-13	
301	A	3'-0" X 6'-8"	H.M.		H.M.	J-1	H-1		A	5		
302	A	3'-0" X 6'-8"	H.M.		H.M.	J-2	H-2			5		
303	B	3'-0" X 6'-8"	H.M.		STL							
501	B	4'-0" X 6'-8"	W.M.		STL							
502	B	4'-0" X 6'-8"	W.M.		STL							
601	A	3'-0" X 6'-8"	H.M.		H.M.	J-1	H-1		A	5	* SEE DETAIL 8 ON A2.10 FOR SADDLE	
602	A	3'-0" X 6'-8"	H.M.		H.M.	J-1	H-1		A	5	* SEE DETAIL 8 ON A2.10 FOR SADDLE	
603	A	3'-0" X 6'-8"	H.M.		H.M.	J-1	H-1		A	5	* SEE DETAIL 8 ON A2.10 FOR SADDLE	
604	A	3'-0" X 6'-8"	H.M.		H.M.	J-1	H-1		A	5	* SEE DETAIL 8 ON A2.10 FOR SADDLE	

NOTE: DOORS 201, 202, 203, 204 & 205 - SOUND TRANSMISSION CLASS RATING = 52 STC

FINISHES

A/ PAINT


- FIELD PAINT AT ALL EXPOSED METAL SURFACES INCLUDING BEAMS, STEEL ANGLES, TRIM, STEEL STAIRS, HANDRAILS, TREADS, FLASHING, DOORS AND FRAMES.
 - BLACK FINISH ALL EXTERIOR LOCATION TO MATCH COMPOSITE ALUMINUM WALL PANELS, ALUMINUM VERTICAL GRILLS AND HORIZONTAL RAIN LOUVERS.
 - SUMMIT GRAY FINISH COAT (COLOR SW21227 BY SHERWIN WILLIAMS OR EQUAL) AT ALL INTERIOR LOCATIONS.
- PROVIDE FACTORY NATURAL FINISH FOR ALL GALVALUME PRODUCTS INCLUDING FLASHING AND TRIM.
- SEE MECHANICAL, ELECTRICAL, AND PLUMBING DRAWING AND SPECIFICATIONS FOR ALL OTHER REQUIREMENTS INCLUDING LOCATIONS, COLORS AND PATTERNS.

B/ PLASTIC LAMINATE


- COLOR NO. 871: TEXTURE CODE SEI (MATTE FINISH) BY ABET LAMINATING INC. TEL 1800-228-ABET OR EQUAL

C/ SEAMLESS RESINOUS FLOORING


- COLOR STEEL GRAY STONCLAD GS/GS4, BY STONHARD OR EQUAL, AT ALL HEATED AREAS STONCLAD HT/HT4, BY STONHARD OR EQUAL, AT ALL UNHEATED AREAS.

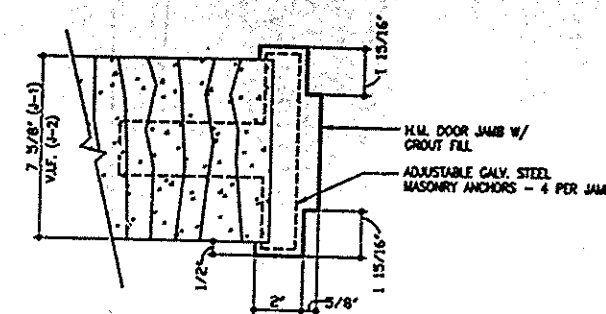


JAMB TYPES

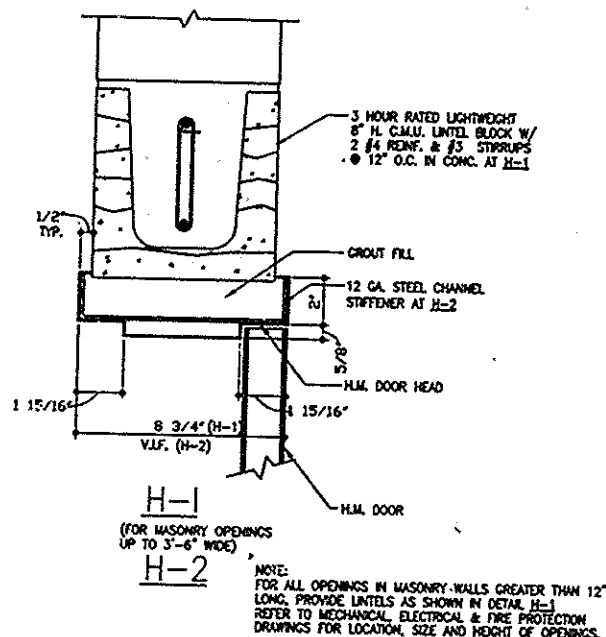


HEAD TYPES (FOR MASONRY OPENINGS UP TO 3'-6" WIDE)

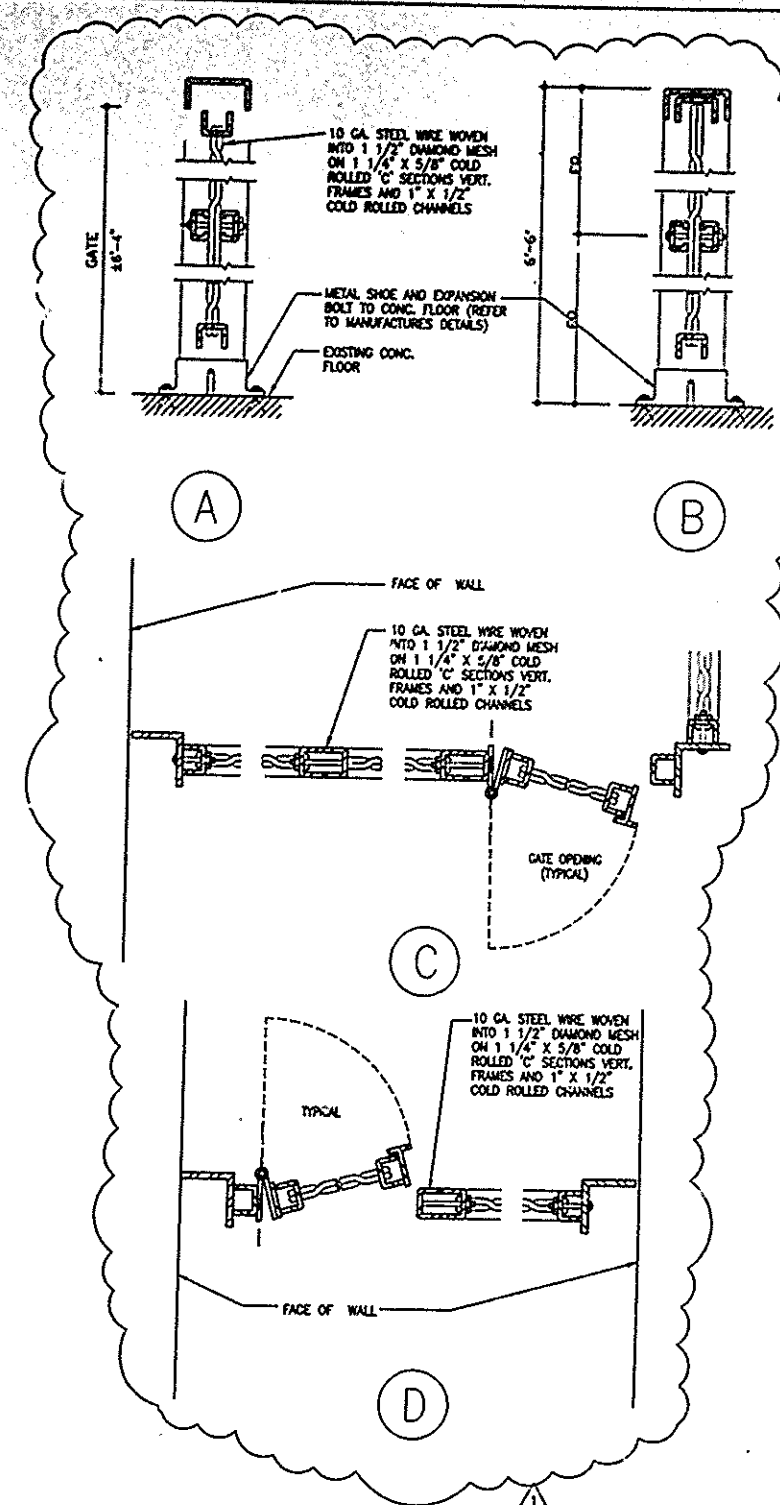


TYPICAL WIRE MESH PARTITION DETAILS

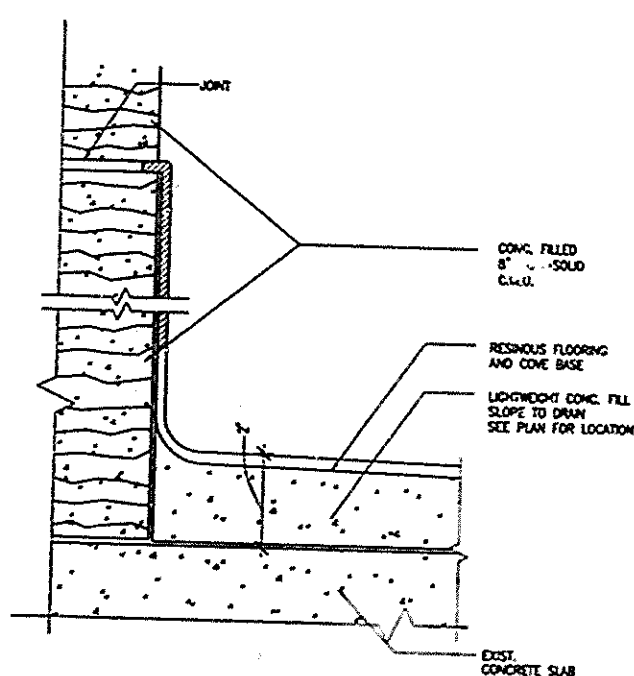


RESINOUS FLOORING AT C.M.U. CURB

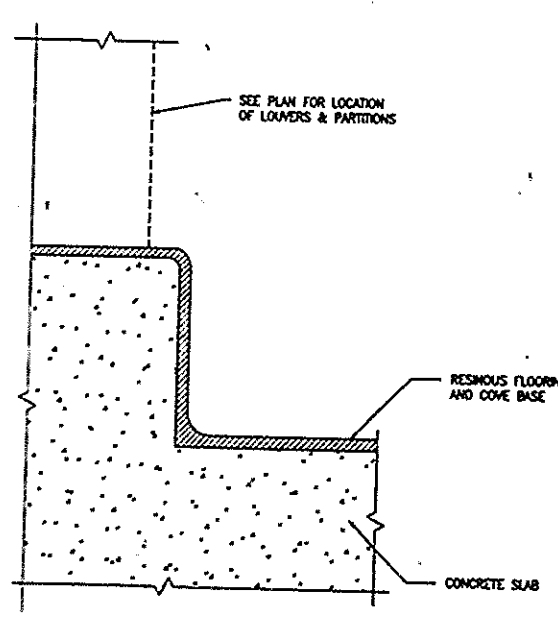


RESINOUS FLOORING AT CONCRETE CURB, PAD

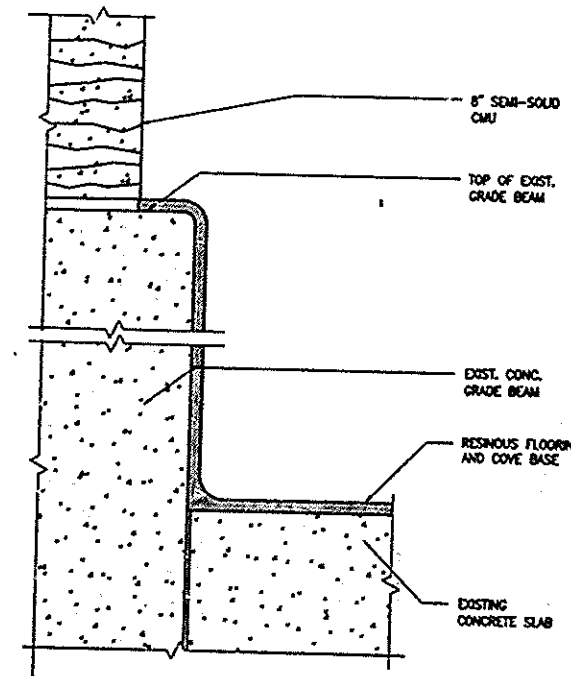


RESINOUS FLOORING AT FUEL OIL TANK ROOM

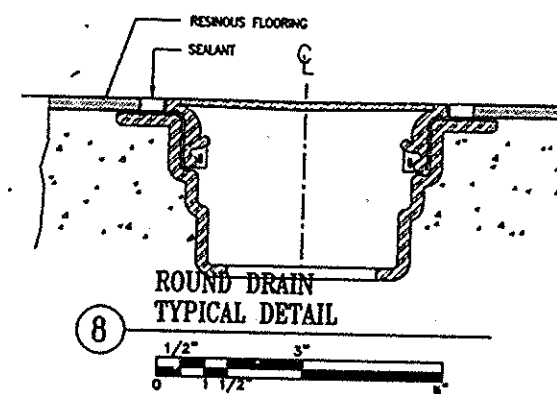


ROUND DRAIN TYPICAL DETAIL

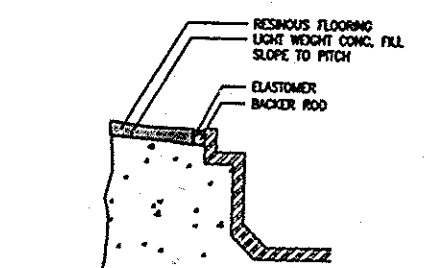

DRAIN DETAIL

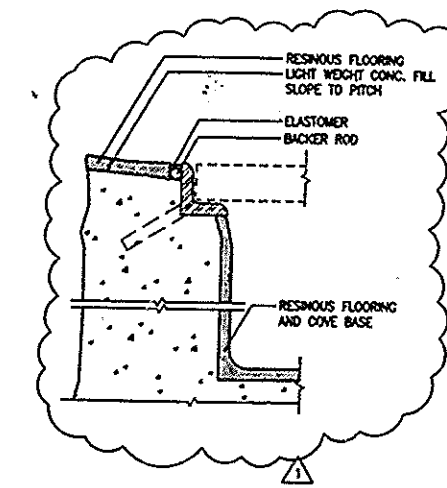

PIT & GRATE COVER DETAIL

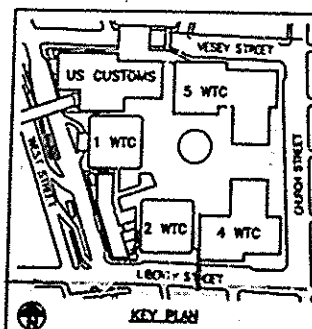

THE PORT AUTHORITY OF NY & NJ



ORIGINAL SIGNED & SEALED BY N.Y. P.E. (OR R.A.)

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I HEREBY CERTIFY THAT THIS IS A TRUE AND CORRECT COPY OF ONE OF THE CONTRACT DRAWINGS, COPIES OF WHICH HAVE BEEN SUBMITTED TO THE PORT AUTHORITY OF NEW YORK AND NEW JERSEY IN THE FORM IN WHICH SAID DRAWINGS WERE SUBMITTED TO THE PORT AUTHORITY OF NEW YORK AND NEW JERSEY FOR THE TIME THE SAID CONTRACT WAS EXECUTED BY THE PARTIES.

DATE: 11/16/98
BY: [Signature]
TITLE: [Signature]

2/12/97 GRADED DOOR & FINISH SCHEDULES & DET.

1/17/97 ISSUED FOR G.C.

No. Date Revision Approved

Engineering Department Design Divisions

The World Trade Center

STANDEY POWER

5 WORLD TRADE CENTER

ARCHITECTURAL

DOOR & FINISH SCHEDULES AND TYPICAL DETAILS

This drawing subject to conditions in contract. All inventions, ideas, designs and methods herein are reserved to Port Authority and may not be used without its written consent.

G.B. D.J.F. Designed by Drawn by J.R.L. Job No.

Date 11/17/97 Scale AS SHOWN

Contract Number Drawing Number

WTC-845.071 A1-01